

ERIE COUNTY MEDICAL CENTER ACCESS ROAD WATER LINE REPLACEMENT

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04-19-2011



Albany Buffalo Rochester Syracuse

DRAWING LIST

L-1 WATERLINE PLAN

VL-2 WATERLINE PROFILE, PIPE ELEVATION AND DEFLECTION CHART

WL-3 TYPICAL DETAILS, GENERAL NOTES, QUANTITIES AND OPERATION NOTES

WL-4 TRAFFIC PLAN

WL-5 TRAFFIC CONTROL DIAGRAMS

WL-6 GRIDER STREET RAMP CLOSURE DETAILS


1 ELECTRICAL - NEW WORK
2 ELECTRICAL - DETAILS


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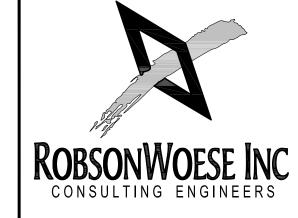




NOTES:

- 1. PROVIDE CLASS A CONCRETE THRUST BLOCKS ACCORDING TO DETAILS SHOWN ON DWG WL-3.
- 2. THE CONTRACTOR IS ADVISED THAT THE DEPTH OF THE EXISTING UTILITIES ARE APPROXIMATE. THE DEPTH OF THE EXISTING WATERLINE WILL NEED TO BE FIELD VERIFIED.
- 3. MECHANICAL JOINT FITTINGS WILL BE REQUIRED AT EACH PIPE JOINT. JOINTS TO BE TORQUED AS PER MANUFACTURERS RECOMMENDATIONS. COST OF FITTINGS, BOLTS, AND RETAINING GLANDS TO BE PAID FOR UNDER ITEM 663.0512.
- 4. ALL WELDING SHALL BE DONE AS REQUIRED BY SCM AND AWWA C206 CODE.
- 5. THE CONTRACTOR SHALL VERIFY THE EXISTING WATERLINE PIPE MATERIAL AND DIAMETER AND PROVIDE SUBMITTAL TO THE ENGINEER OF THE APPROPRIATE MECHANICAL RESTRAINT GLAND.
- 6. CARRIER PIPE SHALL BE 12 NPS STEEL PRESSURE WATER PIPE COMPLYING WITH THE REQUIREMENTS OF AWWA C 200. PIPE INTERIOR SHALL BE COATED WITH COAL TAR ENAMEL AND SHALL COMPLY WITH THE REQUIREMENTS OF AWWA STANDARD C 203.
- 7. EXPANSION JOINT DESIGNED TO CARRY COLD WATER AT 200 PSI MAXIMUM INTERNAL PRESSURE. EXPANSION JOINT AS SUPPLIED BY DRESSER MFG. DIVISION OF BRADFORD. PA OR SMITH-BLAIR CO. OF SAN FRANCISCO, CA. OR OTHER APPROVED EQUIVALENT.
- 8. THE STEEL WATER MAIN SHALL BE FACTORY INSULATED WITH 75 mm POLYURETHANE INSULATION. INSULATION SHALL BE CARRIED AROUND ALL STEEL PIPE AND EXPANSION JOINTS, EXCEPT THAT INSULATION AT EXPANSION JOINTS SHALL NOT RESTRICT OR INTERFERE WITH LONGITUDINAL PIPE MOVEMENT.

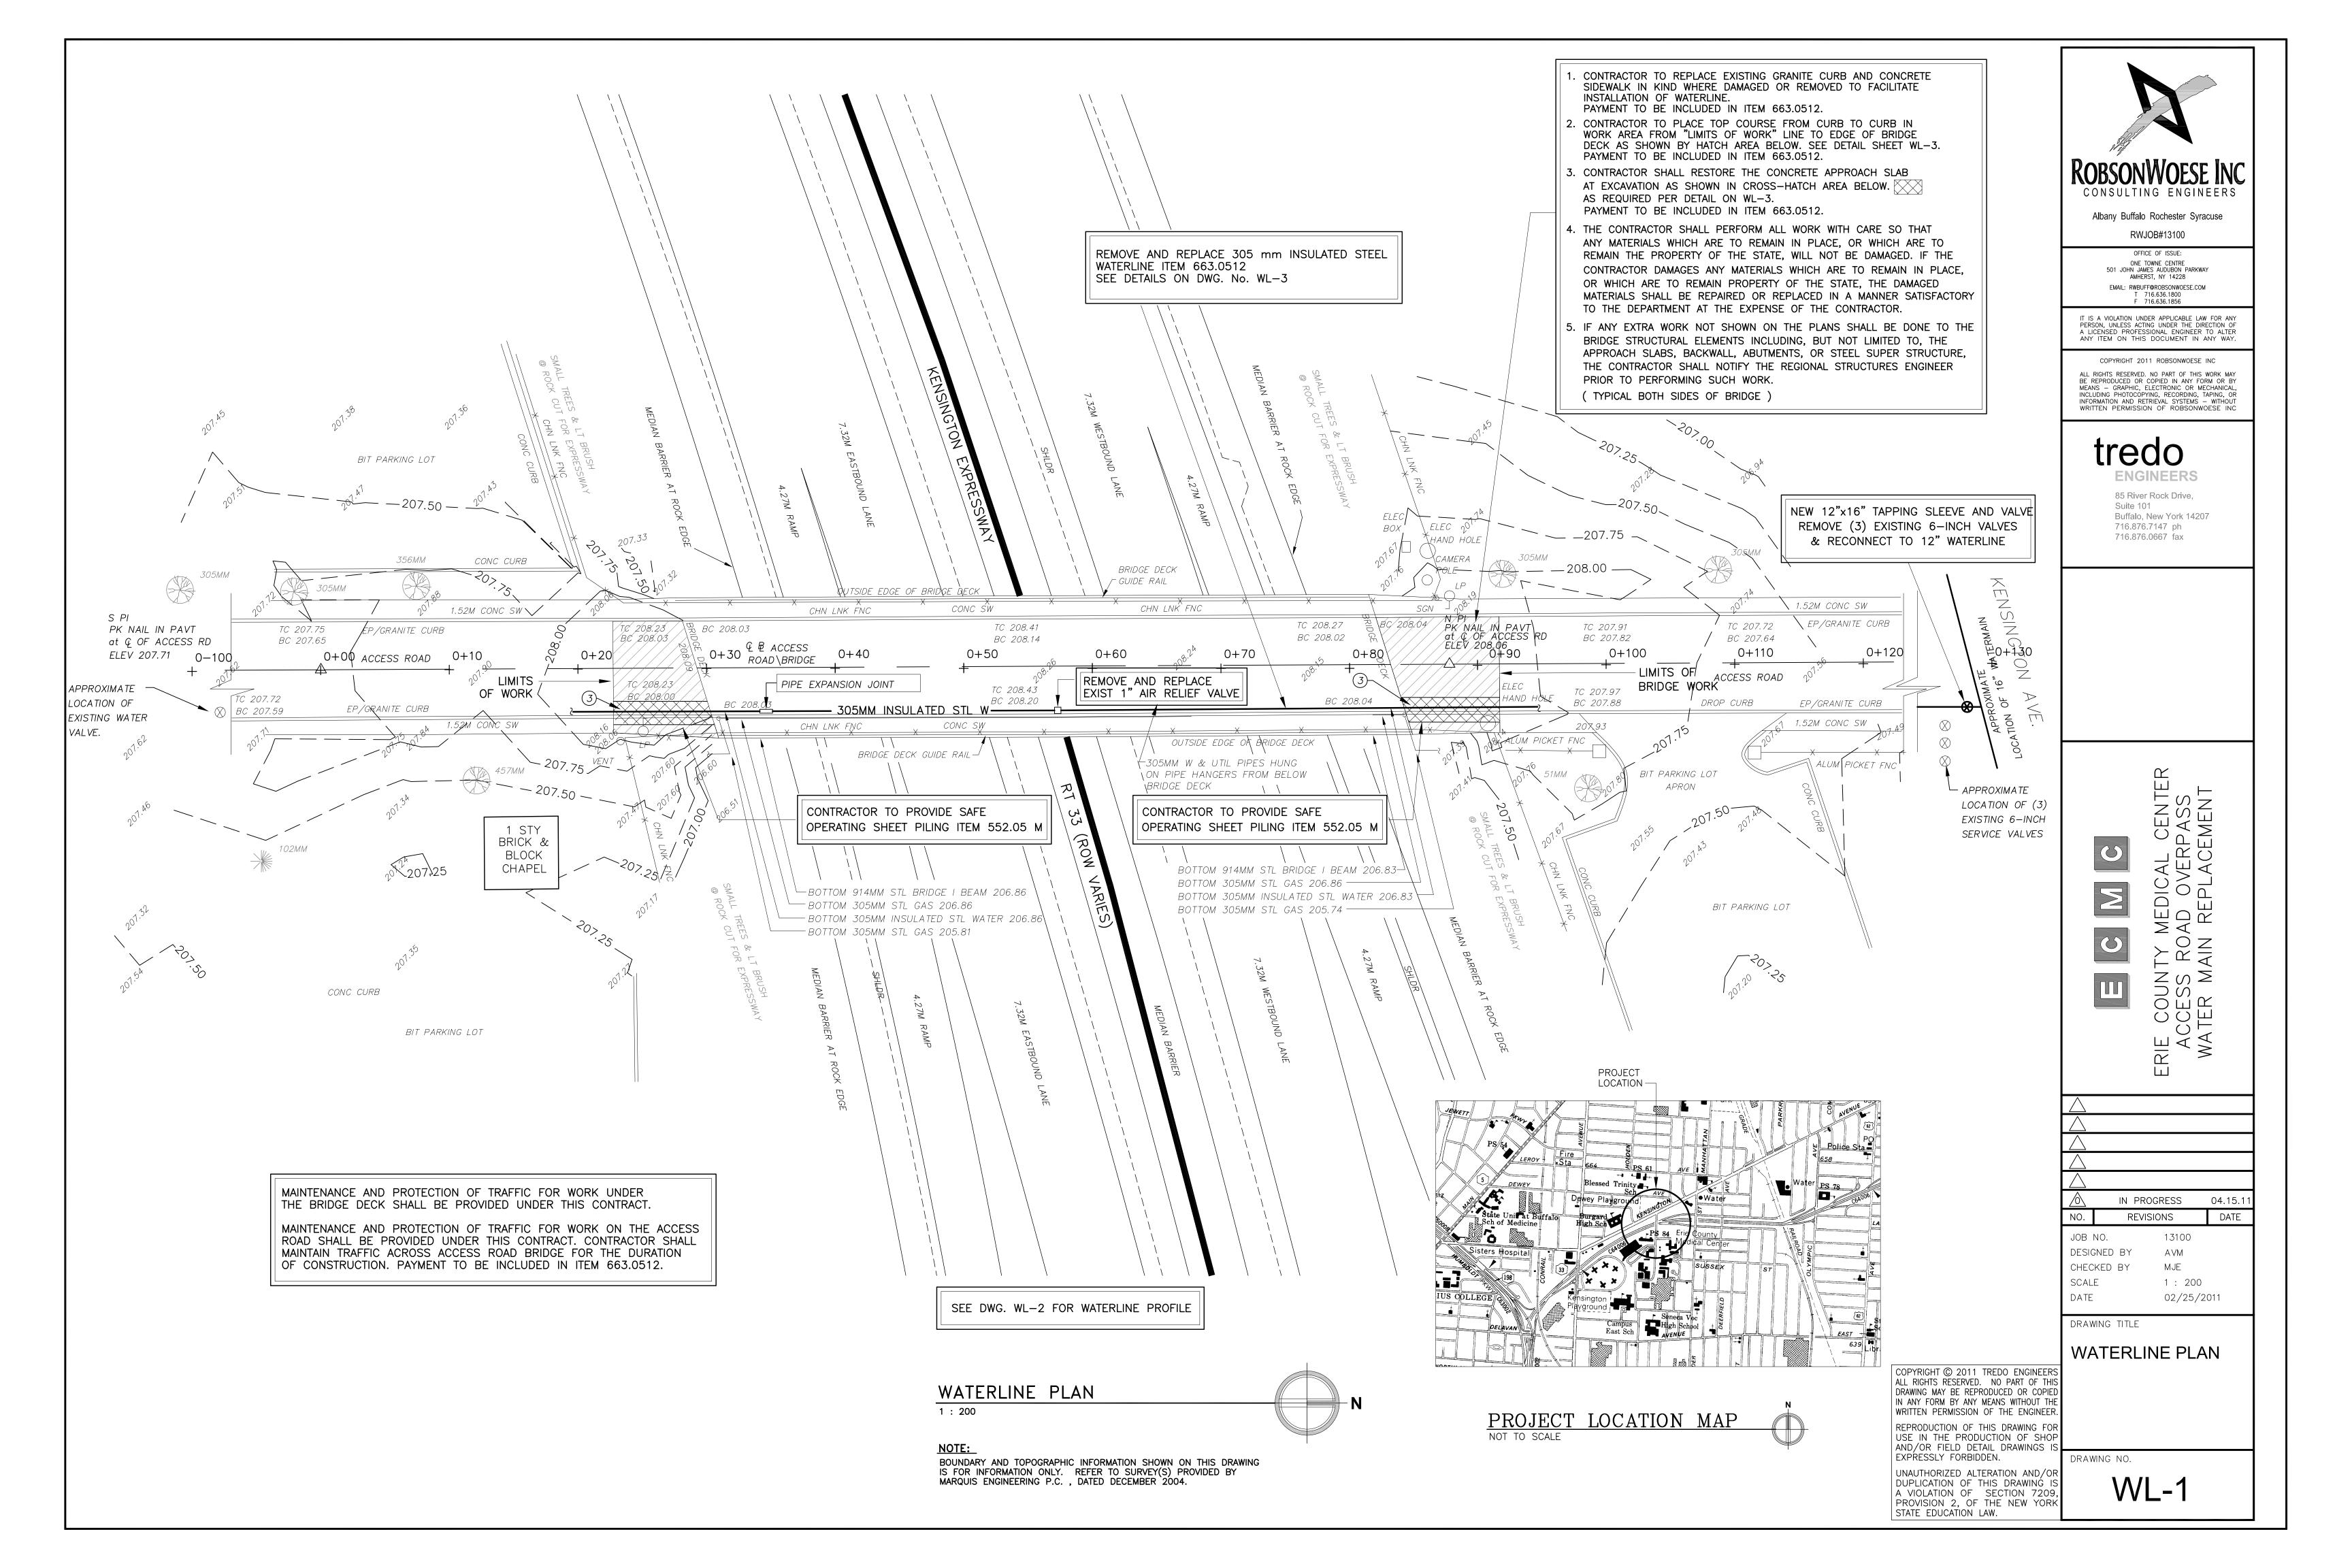- 9. PROTECTIVE JACKET- ALL STRAIGHT SECTIONS OF THE INSULATED PIPING SYSTEM SHALL BE FILAMENT WOUND, POLYESTER RESIN/FIBERGLASS REINFORCEMENT COMPOSITE DIRECTLY APPLIED ON THE INSULATING FOAM. THERMOPLASTIC CASING MATERIAL SHALL NOT BE ALLOWED. ALL FITTINGS OF THE INSULATED PIPING SYSTEM SHALL BE PREFABRICATED TO MINIMIZE FIELD JOINTS AND JACKETED IN A CHOPPED SPRAY UP, POLYESTER RESIN/FIBERGLASS- REINFORCED COMPOSITE, DIRECTLY APPLIED ONTO THE INSULATING FOAM TO A THICKNESS RELATED TO THE FILIMENT-WOUND JACKET THICKNESS.
- 10. ALL PIPE AND APPURTENANCES SHALL COMPLY WITH APPLICABLE CODES OF THE "STANDARD SPECIFICATIONS OF FABRICATED ELECTRONICALLY WELDED STEEL PIPE" OF THE AMERICAN WATER WORKS ASSOCIATION NO. C-200-91 OR LATEST REVISION THEREOF.
- 11. SHOP DRAWINGS SHALL BE SUBMITTED TO THE ENGINEER FOR APPROVAL AND SHALL SHOW THE LOCATION, SIZE, MANUFACTURER'S NAME AND IDENTIFICATION NUMBER OF ALL COMPONENT PARTS. THE ENGINEER MAY TAKE NO EXCEPTION TO THESE SHOP DRAWINGS IF THEY ARE IN CONFORMANCE WITH THE CONTRACT PLANS AND SPECIFICATIONS, RETURN THE SHOP DRAWINGS TO THE CONTRACTOR FOR CORRECTIONS, OR REJECT THE SHOP DRAWINGS. IF THE SHOP DRAWINGS ARE RETURNED FOR CORRECTIONS OR REJECTED, THE CONTRACTOR SHALL RESUBMIT SHOP DRAWINGS WHICH ARE IN CONFORMANCE WITH THE CONTRACT DOCUMENTS AND THE ENGINEERS COMMENTS.
- 12. CONTRACTOR TO PROVIDE STEEL SLEEVE AT BRIDGE ABUTMENTS TO ALLOW FREE LONGITUDINAL MOVEMENT OF WATER MAIN.

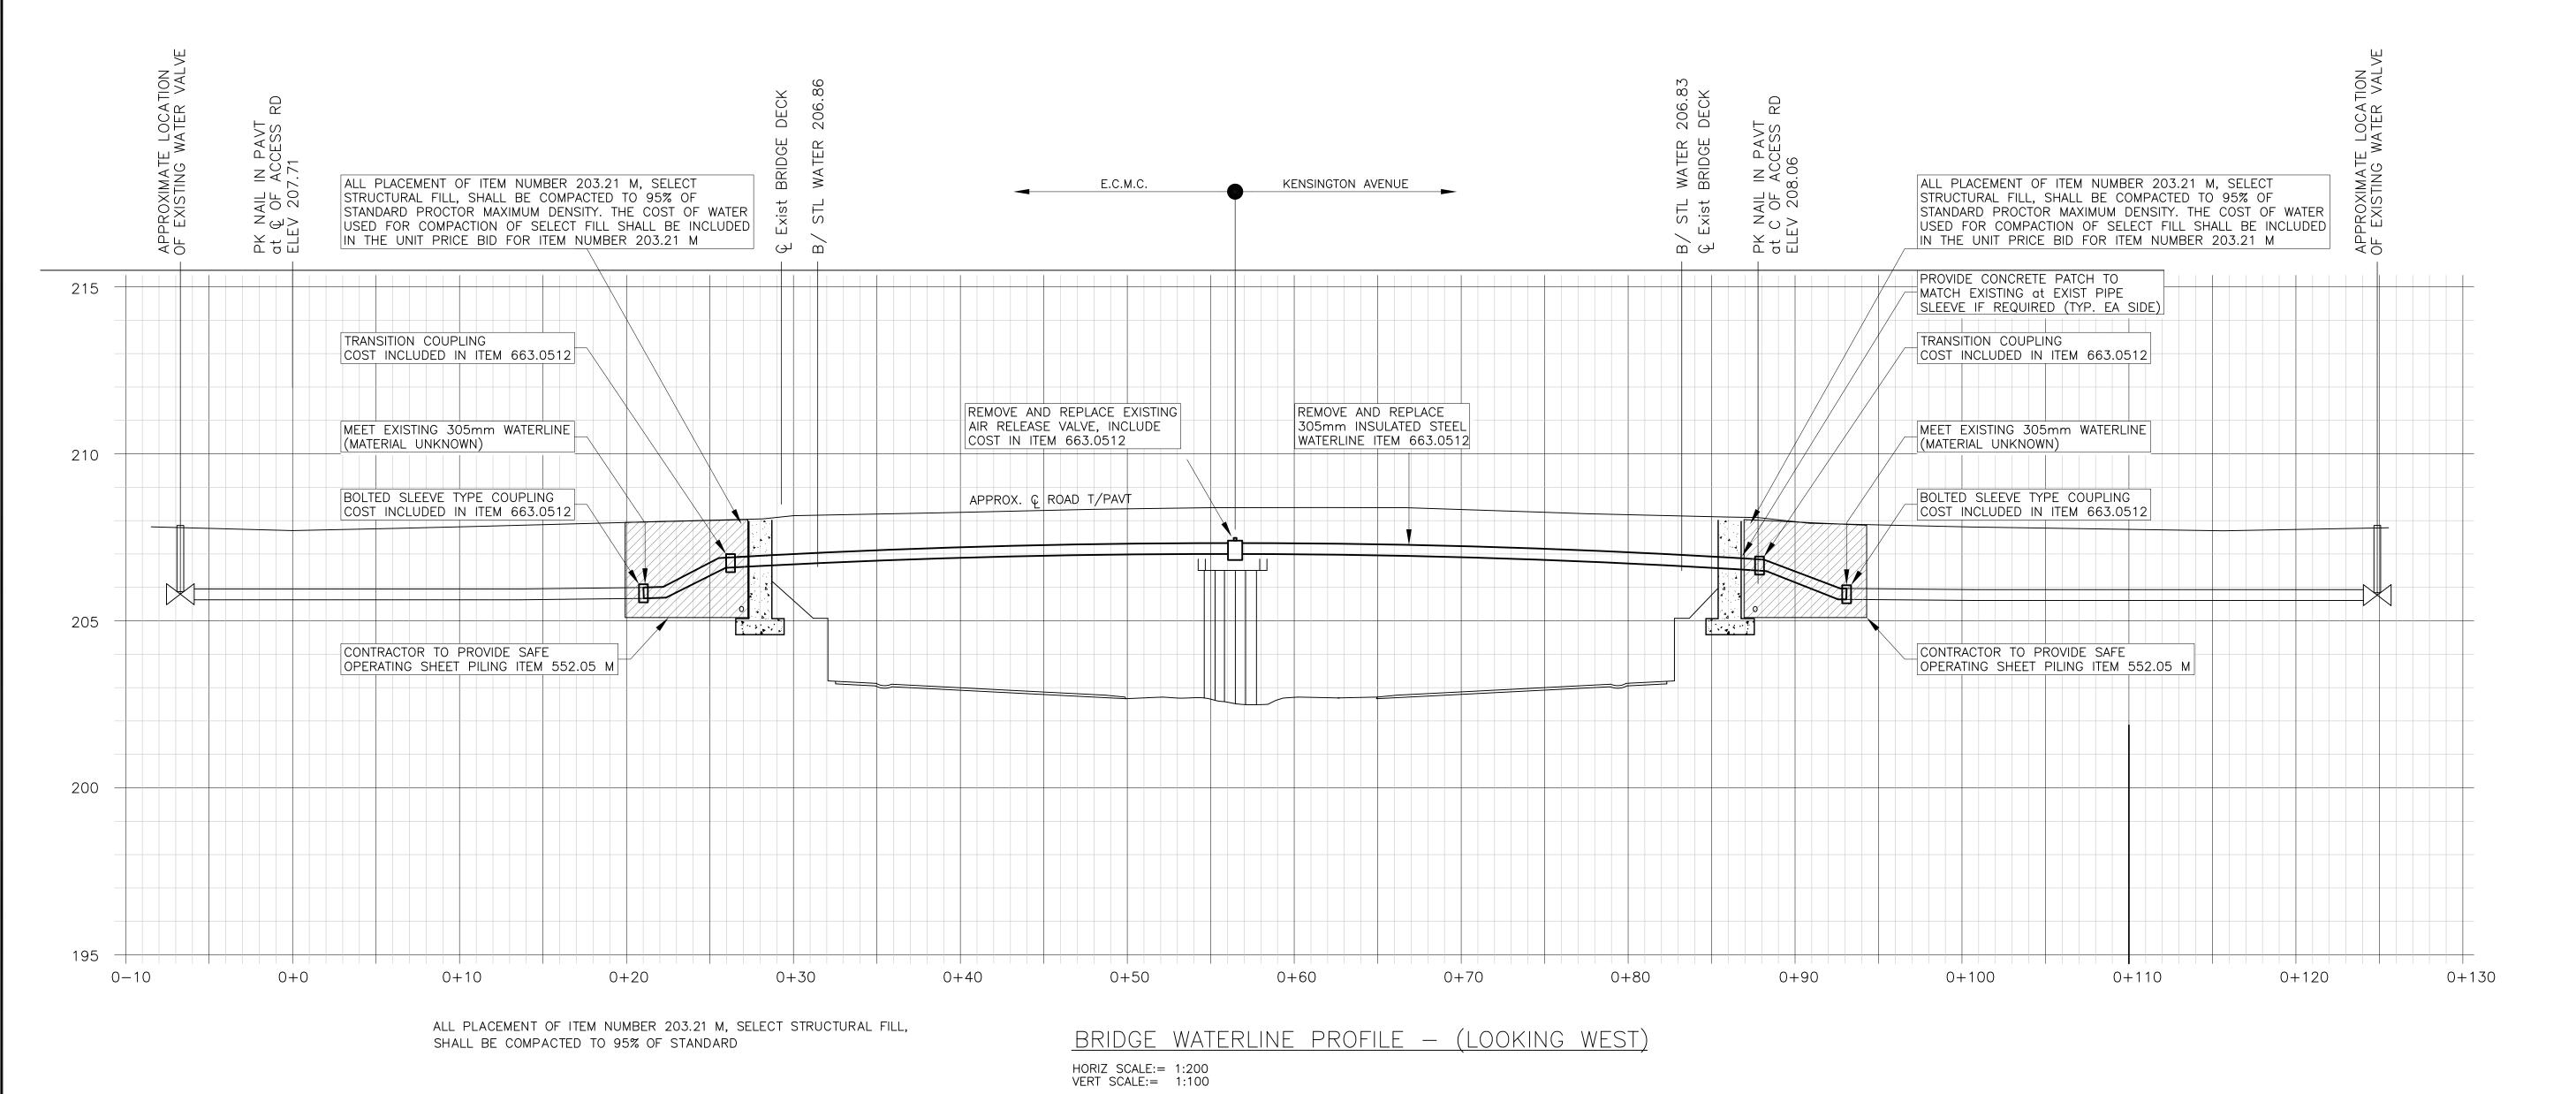

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JOB NO. 13100 DESIGNED BY AVMCHECKED BY MJE SCALE AS NOTED DATE 02/25/2011

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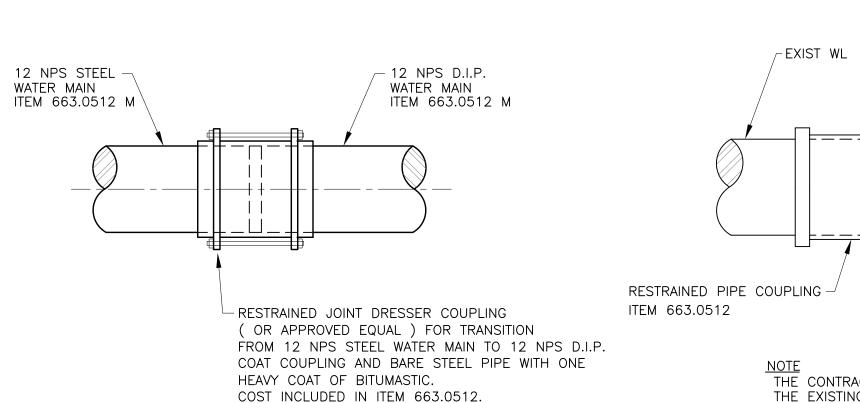
WATERLINE PROFILE AND PIPE ELEVATION AND DIRECTION

DRAWING NO.


WL-2

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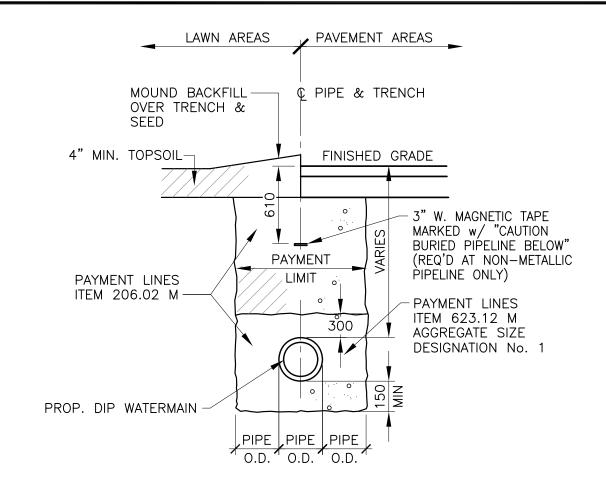


TYPICAL CONNECTION DETAIL (DUCTILE TO STEEL)




THE CONTRACTOR WILL MAKE THE FINAL CONNECTIONS TO THE EXISTING WATER MAIN. HOWEVER THE CONTRACTOR IS RESPONSIBLE FOR SUPPLYING ALL MATERIALS, INCLUDING EXCAVATION AND BACKFILL. THE CITY OF BUFFALO WILL OPERATE ALL VALVES INVOLVED.

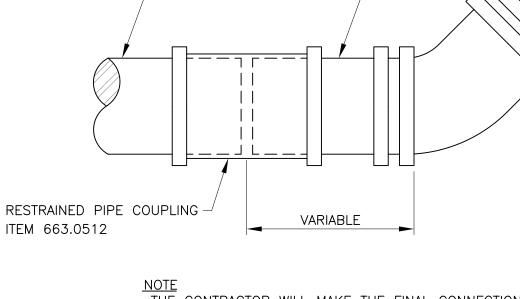
TYPICAL CONNECTION DETAIL (DUCTILE TO EXISTING PIPE)




TYPICAL WATERLINE **TRENCH**

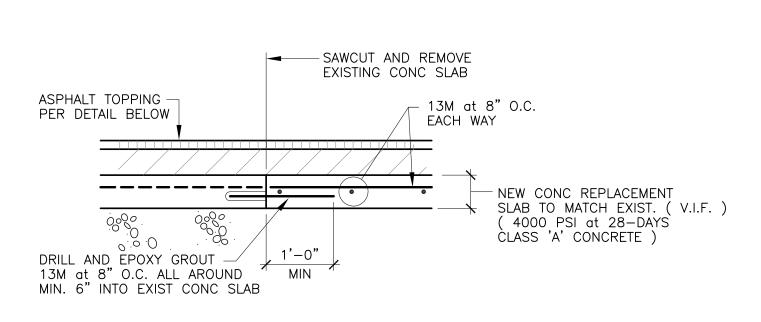


CONCRETE APPROACH SLAB REPLACEMENT SECTION

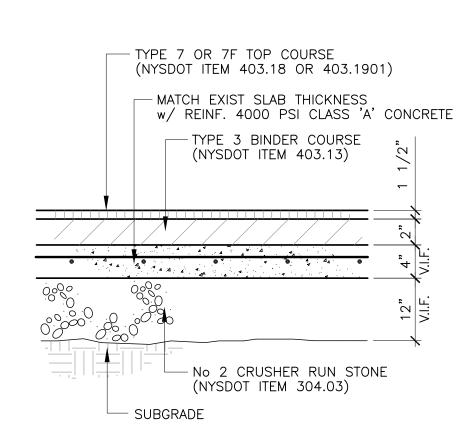



ROAD CUT REPLACEMENT PAVEMENT SECTION

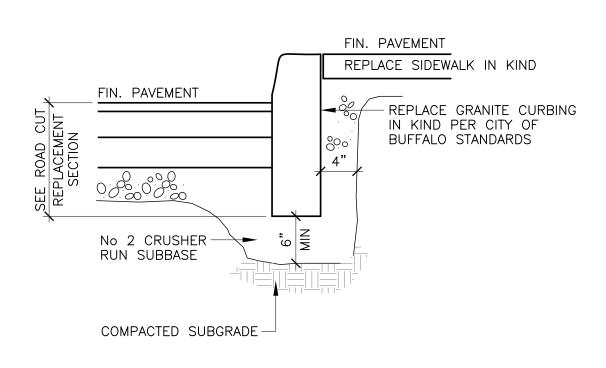

TYPICAL PAVEMENT REPLACEMENT SECTION WITH CURB

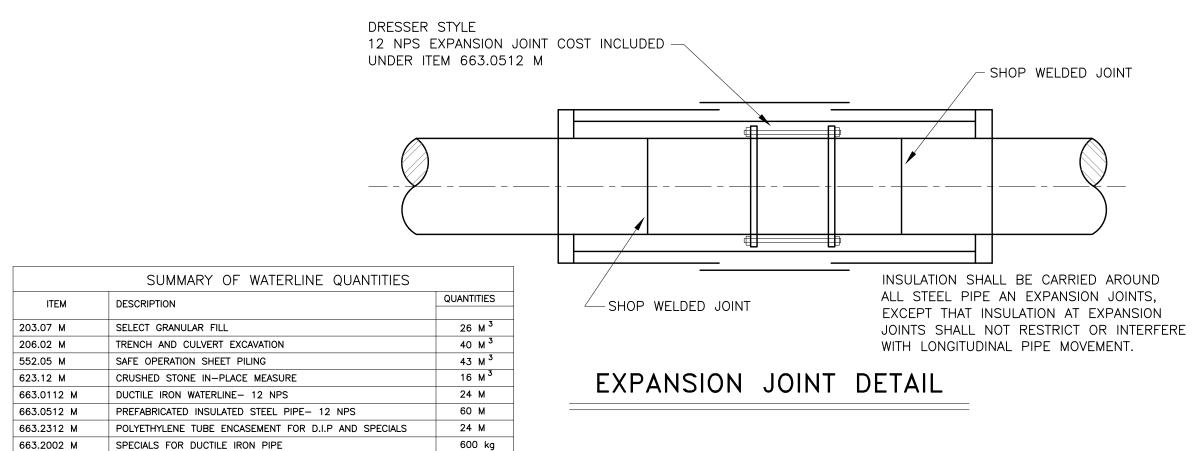

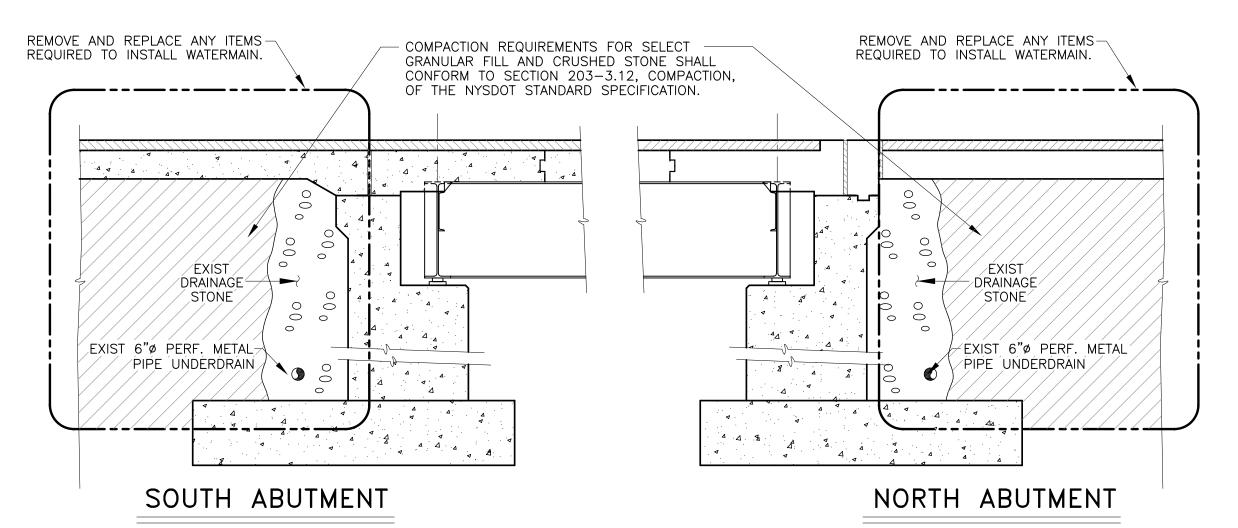

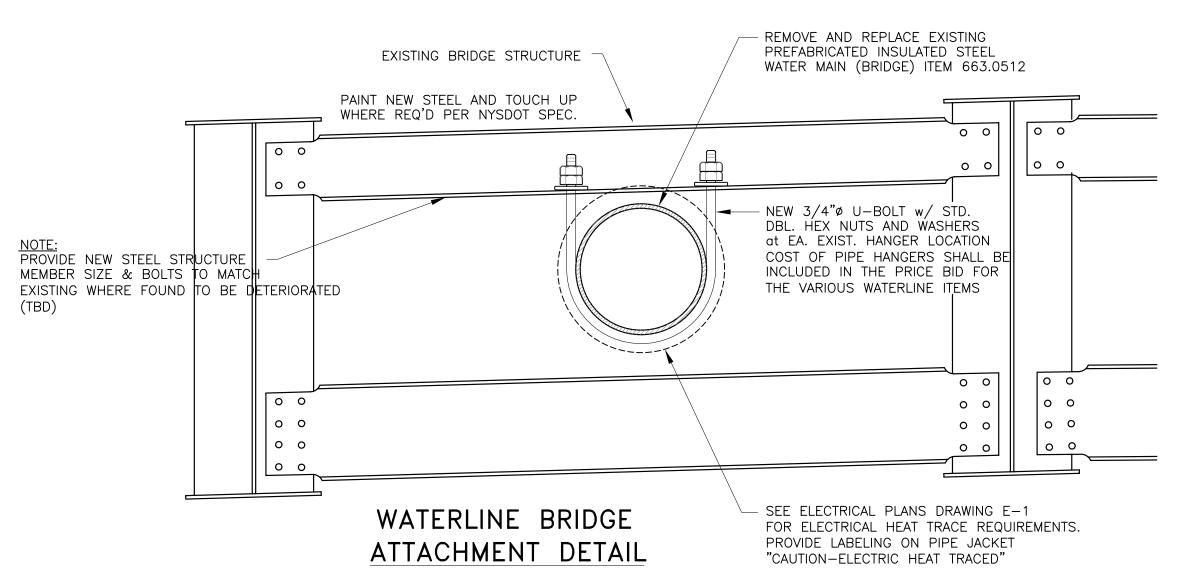



GENERAL NOTES

- 1. ALL INSTALLATIONS ARE TO BE IN ACCORDANCE WITH BUFFALO DIVISION OF WATER/ECWA AND ALL OTHER APPLICABLE REGULATORY AGENCY STANDARDS AND SPECIFICATIONS.
- 2. RECORD PLAN INFORMATION PROVIDED BY UTILITY OWNERS HAS BEEN PLOTTED ON THE CONTRACT PLANS. PHYSICAL SURFACE FEATURES, SUCH AS VALVE BOXES AND HYDRANTS, HAVE BEEN FIELD LOCATED. DEPTHS WERE ESTIMATED FROM EITHER NEARBY VALVES OR EXCAVATIONS. CONTRACTOR SHALL FIELD VERIFY ALL EXISTING UTILITY INFORMATION.
- 3. THE CONTRACTOR SHALL PERFORM TEST PITS AT EXISTING PIPES, VALVES ETC. AS SHOWN ON THE DRAWINGS OR AS DIRECTED BY THE ENGINEER. THE PIPE LAYING SCHEDULE SHOULD REFLECT THE FIELD INFORMATION OBTAINED BY THE TEST PITS. THE STATIONING OF COUPLINGS AND BENDS SHOULD COORDINATE WITH THE TEST PIT INFORMATION IN ORDER TO FACILITATE CONSTRUCTION OF THE NEW PIPELINES AND CONSTRUCTION OF THE INTERCONNECTIONS. TEST PITS SHALL BE PAID FOR UNDER ITEM 206.02 M
- 4. THE CONTRACTOR SHALL DEWATER TRENCHES, EXISTING MAINS, ETC. AS REQUIRED TO MAINTAIN A DRY TRENCH WHILE WORK IS BEING PERFORMED.
- 5. TEMPORARY CAPS SHALL BE WATERTIGHT AND SHALL REMAIN IN PLACE UNTIL THE ACTUAL INTERCONNECTIONS ARE MADE.
- 6. CAPS FOR PLUGS ON IRON PIPE SHALL BE MECHANICALLY RESTRAINED WATER-TIGHT CAPS OR PLUGS COMPATIBLE WITH THE PIPE BEING CAPPED AND SUITABLE TO RESIST THRUST DUE TO OPERATING PRESSURES OR AS DIRECTED BY THE ENGINEER.
- 7. CONNECTIONS AT ALL FITTINGS, AND AS SHOWN ON THE PLANS, SHALL BE RESTRAINED JOINTS.
- 8. THE CONTRACTOR SHALL MAKE THE FINAL INTERCONNECTIONS, HOWEVER THE CONTRACTOR IS RESPONSIBLE FOR SUPPLYING ALL MATERIALS INCLUDING EXCAVATION AND BACKFILL. THE CITY OF BUFFALO WILL OPERATE ALL VALVES INVOLVED.
- 9. NO INTERCONNECTIONS WILL BE MADE BY THE CONTRACTOR UNTIL THE PROPOSED PIPELINES AND END OF LINE VALVES HAVE BEEN INSTALLED, TESTED AND DISINFECTED AND THE ENGINEER AUTHORIZES THE INTERCONNECTION.
- 10. SEE ELECTRICAL PLANS E-1 FOR HEAT TRACE REQUIREMENTS.


RECOMMENDED SEQUENCE OF OPERATIONS FOR 12 NPS WATERLINE

- 1. THE CONTRACTOR SHALL INSTALL THE 12 NPS WATERLINE BETWEEN STATIONS 0+21 AND 0+93 SHOWN ON DWG No. WL-1. LAY THE PIPE AS CLOSE AS POSSIBLE TO ITS PROPOSED TIE IN POINTS AND PLUG THE ENDS.
- 2. CONTRACTOR SHALL PROVIDE A FILL/TEST FITTING ON THE NEW WATERLINE TO FACILITATE THE TESTING AND DISINFECTION OF THE NEW WATERLINE.
- 3. PERFORM HYDROSTATIC TESTS. THIS WORK SHALL BE INCLUDED UNDER TESTING PROCEDURES. NO SEPARATE PAYMENT WILL BE MADE.
- 4. AFTER COMPLETION OF HYDROSTATIC TESTS, FLUSH AND DISINFECT THE WATERLINES IN ACCORDANCE WITH STANDARD METHODS OF THE WATER AUTHORITY AND ERIE COUNTY DEPARTMENT OF HEALTH REQUIREMENTS AND RECEIVE ERIE COUNTY DEPARTMENT OF HEALTH APPROVAL. NO SEPARATE PAYMENT WILL BE MADE.
- 5. UPON APPROVAL OF THE TEST RESULTS, THE CONTRACTOR SHALL MAKE THE INTERCONNECTION BETWEEN THE NEW AND EXISTING 12 NPS WATERLINE AT STATIONS 0+21 AND 0+93.

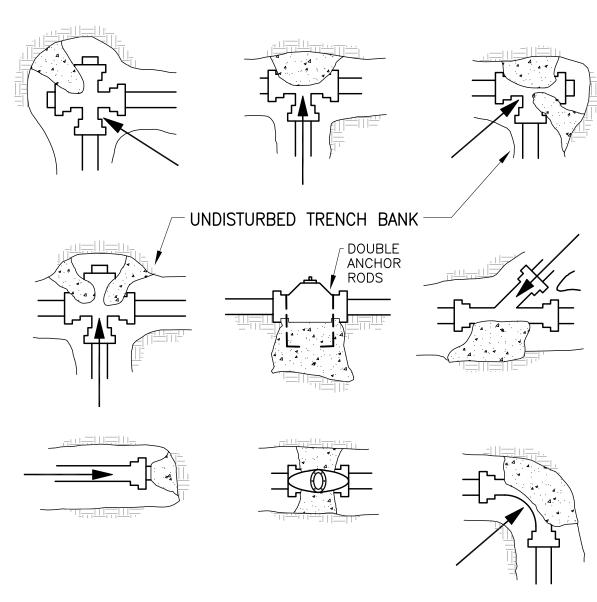

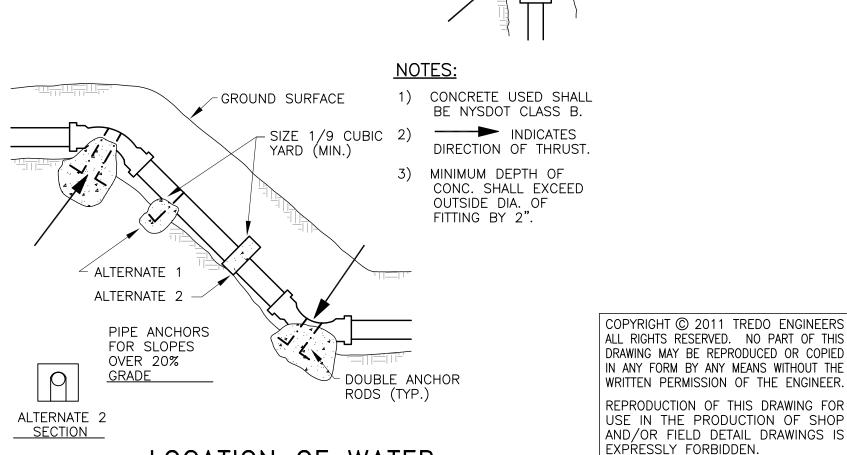

LOCATION OF WATER LINE REACTION BACKING

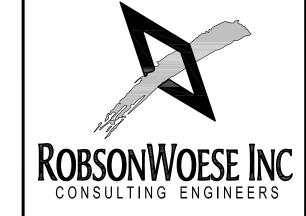

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TYPICAL DETAILS, GENERAL NOTES, QUANTITIES, AND OPERATION NOTES

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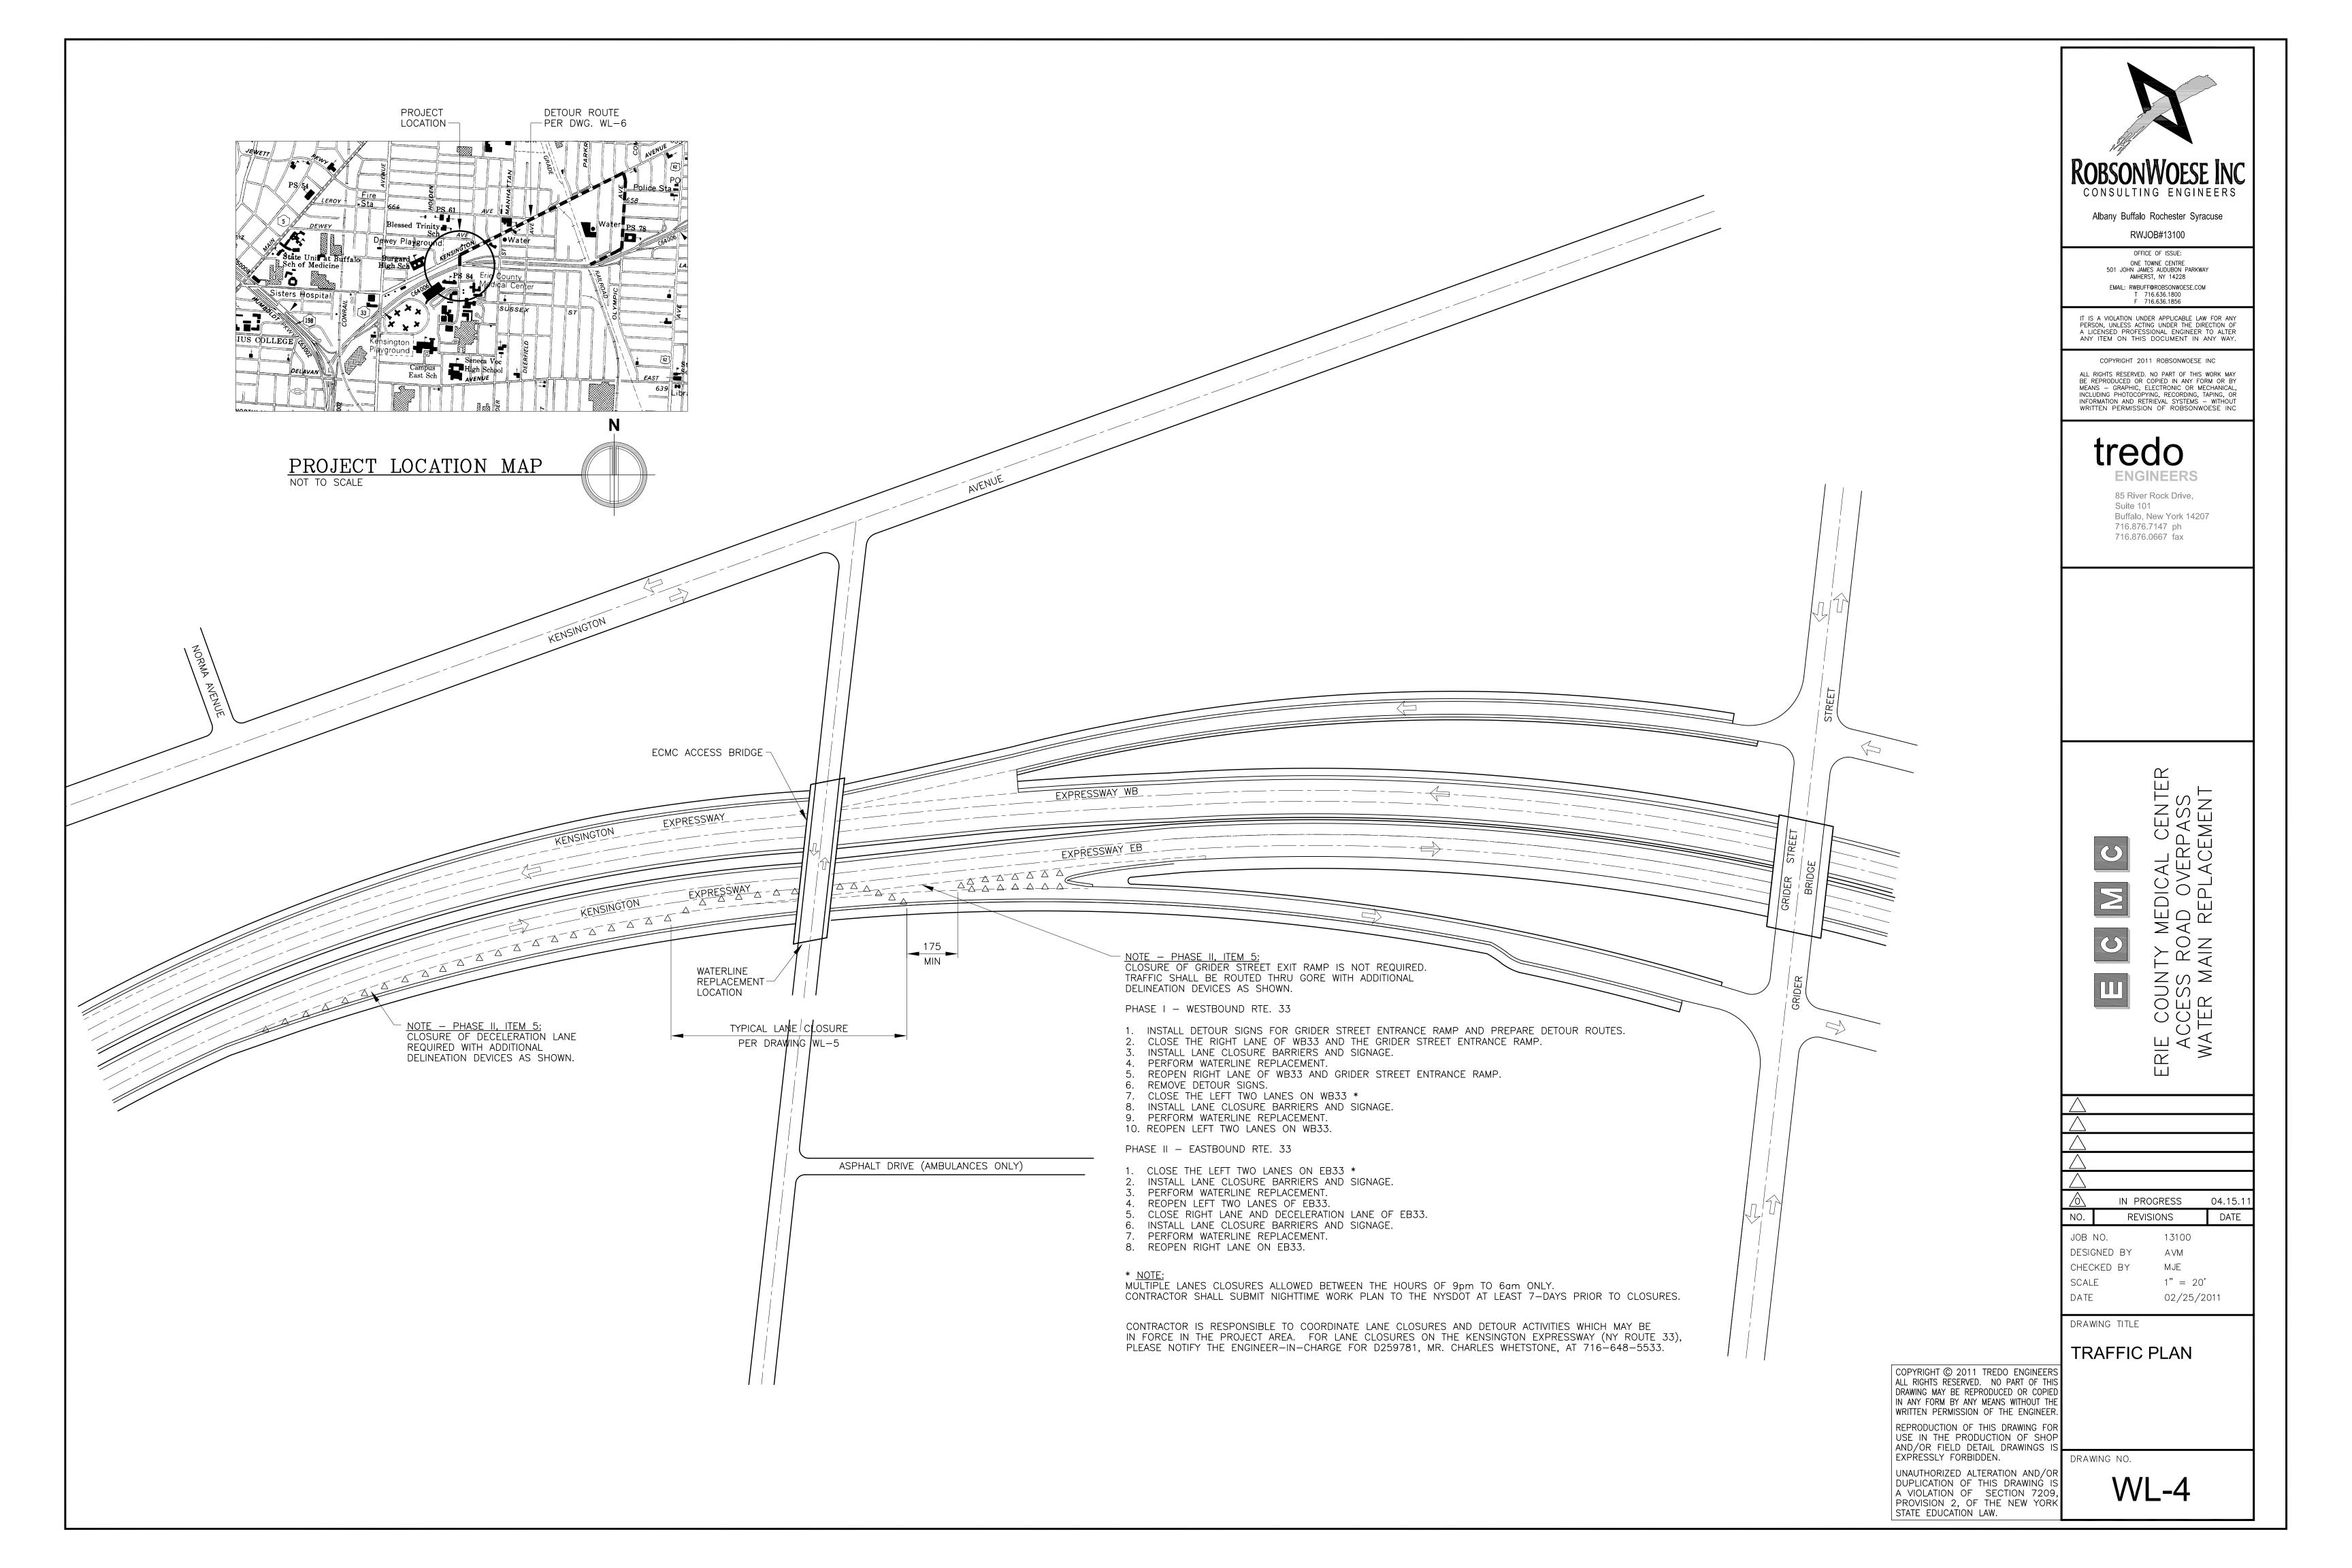
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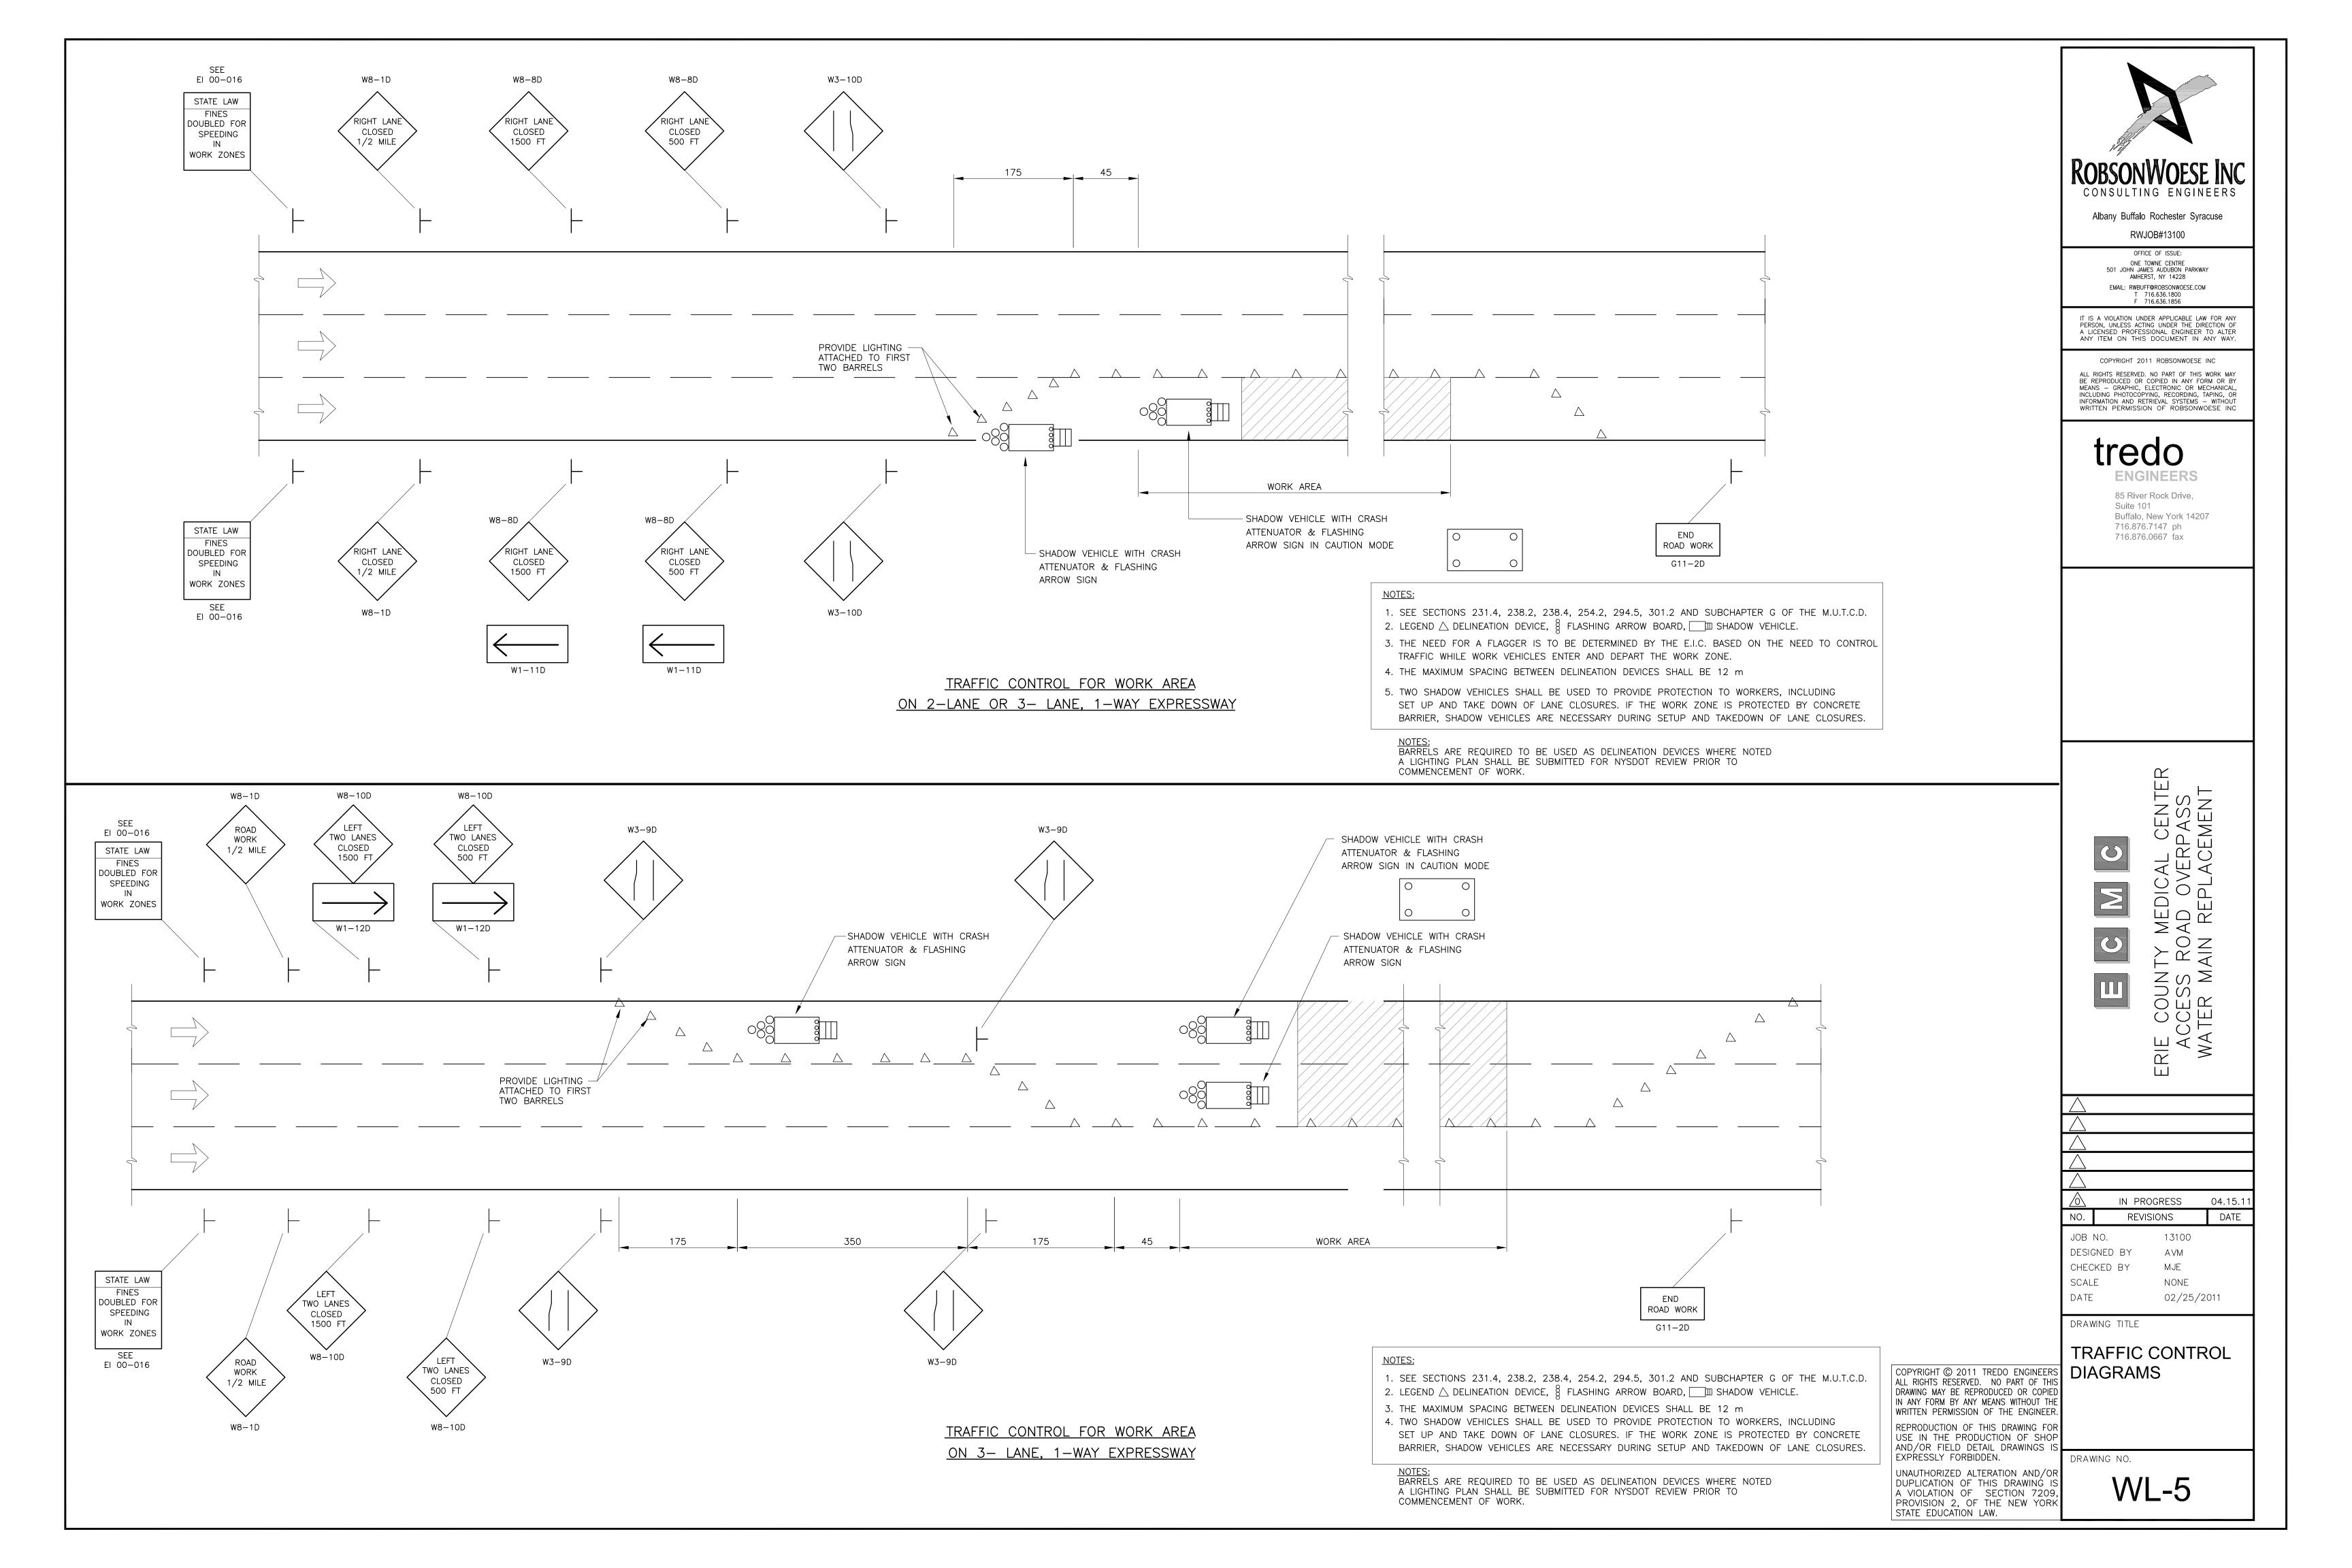
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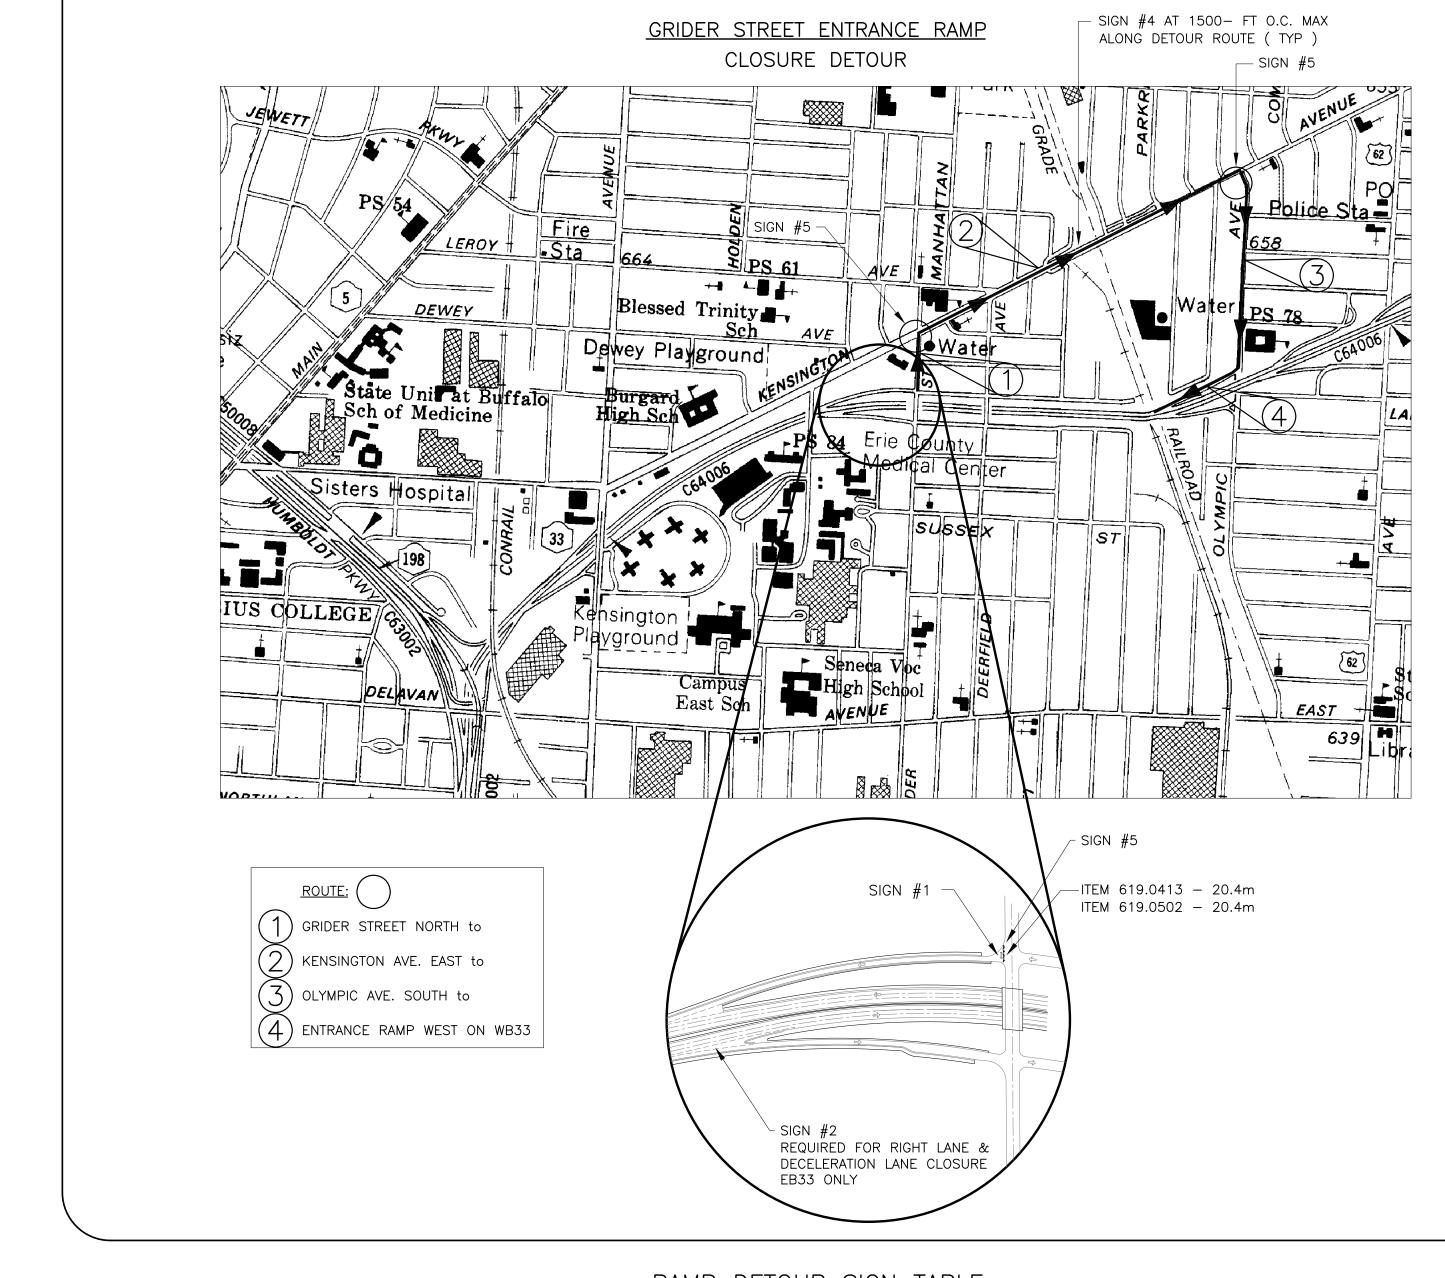
DUPLICATION OF THIS DRAWING

STATE EDUCATION LAW.

WL-3







RAMP DETOUR SIGN TABLE

SIGN NUMBER	LEGEND	M.U.T.C.D. NUMBER	LOCATIONS	SIZE (mm)
1	ROAD CLOSED	R8-1C	*	1219 X 762
2	EXIT	G5-1Y	*	1524 X 1219
3	NOT USED		*	
4	DETOUR WEST 33	M14-25X M13-14X M3-1X M13-43X	*	750 X 375 750 X 375 900 X 900 750 X 525
5	DETOUR WEST 33	M14-25X M13-14X M3-1X M13-43X	*	750 X 375 750 X 375 900 X 900 750 X 525
6	NOT USED		*	
7	NOT USED		*	
8	NOT USED		*	

IE COUNTY MEDICAL CENTER ACCESS ROAD OVERPASS VATER MAIN REPLACEMENT

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DESIGNED BY AVM

CHECKED BY MJE

SCALE NONE

DATE 02/25/2011

DRAWING TITLE

GRIDER STREET
RAMP CLOSURE
DETAILS

DRAWING NO.

WL-6

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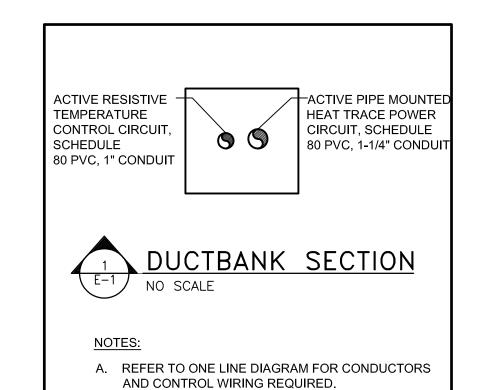
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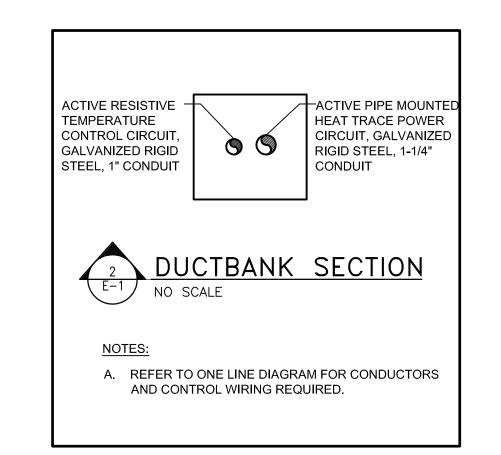
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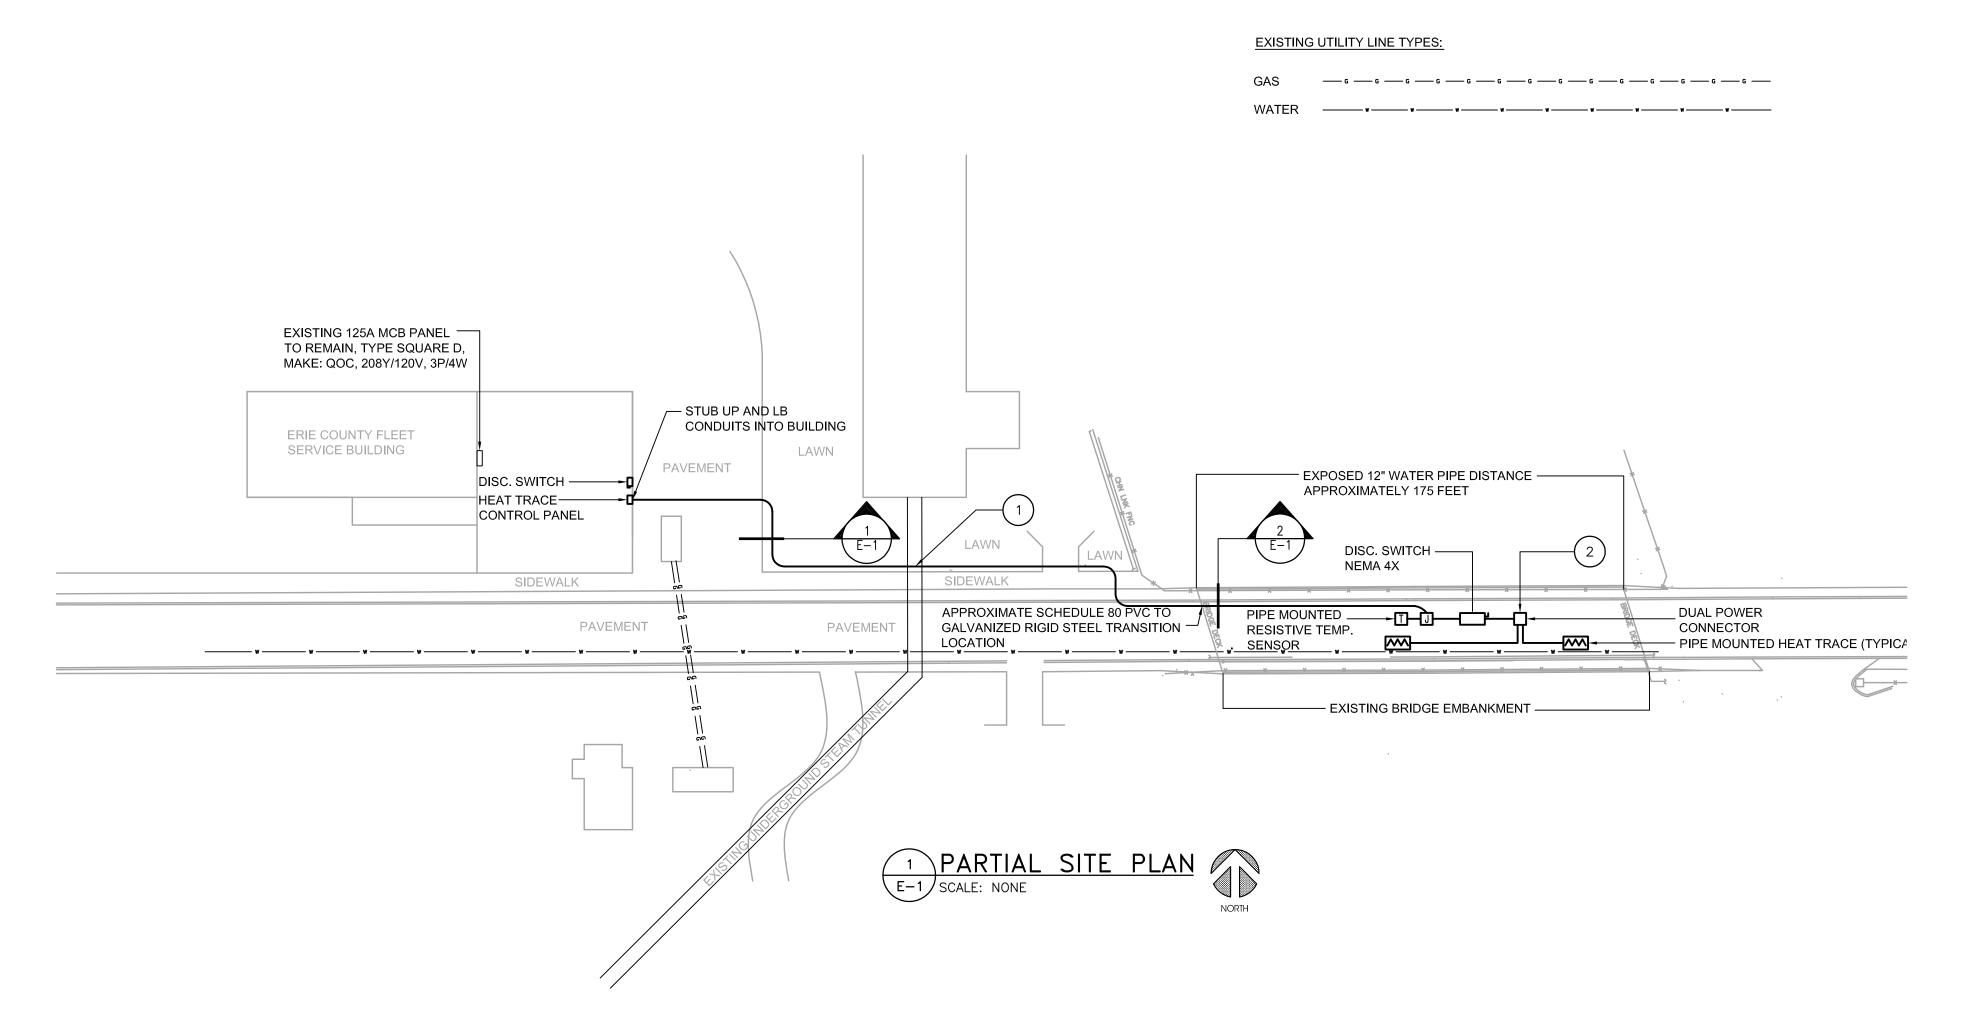
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ELECTRICAL SYMBOLS LIST					
	EXISTING EQUIPMENT/WORK				
	NEW EQUIPMENT/WORK				
1 1	REFERENCE TO DRAWING NOTE				
	EXISTING SURFACE MOUNTED BRANCH CIRCUIT PANELBOARD				
IJ	JUNCTION BOX				
Ⅱ	RESISTIVE TEMPERATURE SENSOR				
***	HEAT TRACE				








GENERAL NOTES:

- A. ALTHOUGH EVERY ATTEMPT HAS BEEN MADE TO INDICATE EXISTING UTILITIES AS ACCURATELY AS POSSIBLE FROM EXISTING SURVEYS, DRAWINGS, AND OTHER DATA, OTHER UTILITIES MAY BE PRESENT OR PLACED IN DIFFERENT LOCATIONS. VERIFY EXACT LOCATION OF EXISTING UTILITIES BY TEST HOLES OR SITE INVESTIGATION BEFORE EXCAVATING. NOTIFY THE UNDERGROUND FACILITIES PROTECTION ORGANIZATION (UFPO), TO LOCATE UTILITIES BEFORE WORK COMMENCES OR HIRE A PRIVATE LOCATING AGENCY.
- B. PROTECT AND MAINTAIN INTEGRITY OF EXISTING UTILITIES. CAREFULLY HAND EXCAVATE WHERE CROSSING EXISTING UTILITIES OR WHERE IN THE VICINITY OF EXISTING UTILITIES. FIELD VERIFY EXISTING LOCATIONS.
- C. DUCTBANK ROUTING IS DIAGRAMMATIC. ACTUAL ROUTING SHALL BE DETERMINED IN THE FIELD. COORDINATE WITH OTHER UTILITIES.
- D. PROVIDE SURFACE CUTS AND RESTORATION OF ALL SIDEWALKS, PAVEMENT, LAWN AREAS, AND PLANTINGS AS REQUIRED TO MATCH EXISTING CONDITIONS. CONTRACTOR SHALL FIELD VERIFY EXACT FIELD CONDITIONS AND PROVIDE THE APPROPRIATE SURFACE CUT AND RESTORATION WORK AS DETAILED ON DETAIL DRAWINGS.
- E. DUCTBANK SHALL BE CONCRETE ENCASED UNDER PAVEMENT AND SIDEWALK AREAS. LAWN AREAS SHALL BE IN SANDBED. REFER TO DETAILS.
- F. PROVIDE UPDATED PANELBOARD DIRECTORIES FOR ANY ALTERATIONS TO EXISTING POWER PANELS.
- G. ALL ELECTRICAL EXPOSED WORK UNDER BRIDGE EMBANKMENT SHALL BE TAMPERPROOF.
- H. BASIS OF DESIGN FOR HEAT TRACE: TYCO THERMO CONTROLS. COORDINATE WITH VENDOR FOR HEAT TRACE DESIGN. REFER TO PERFORMANCE BASED SPECIFICATION FOR HEAT TRACE SYSTEM REQUIREMENTS.
- I. PRIOR TO COMMENCEMENT OF ANY ELECTRICAL WORK, VERIFY ALL ELECTRICAL REQUIREMENTS FOR HEAT TRACE SYSTEM WITH VENDOR.
- J. ALL ABOVE GRADE CONDUIT EXPOSED TO THE EXTERIOR SHALL BE GALVANIZED RIGID STEEL CONDUIT. PROVIDE PVC TO GALVANIZED RIGID STEEL ADAPTER BEFORE STUBBING UP ABOVE GRADE.

KEYED NOTES:

- 1 PROVIDE CONCRETE ENCASEMENT OVER EXISTING UNDERGROUND STEAM TUNNEL.
- PROVIDE HEAT TRACE DUAL POWER CONNECTOR AND POWER HEAT TRACE FROM THE (2) CENTER OF 12" WATERLINE. FROM THE POWER CONNECTOR, HEAT TRACE SHALL EXTEND EAST AND WEST ACROSS THE EXPOSED 12" WATERLINE AND EXTEND 25' UNDERGROUND ON BOTH ENDS PAST THE BRIDGE DECK. REFER TO MANUFACTURER REQUIREMENTS FOR ROUTING OF HEAT TRACE ON WATERLINE.

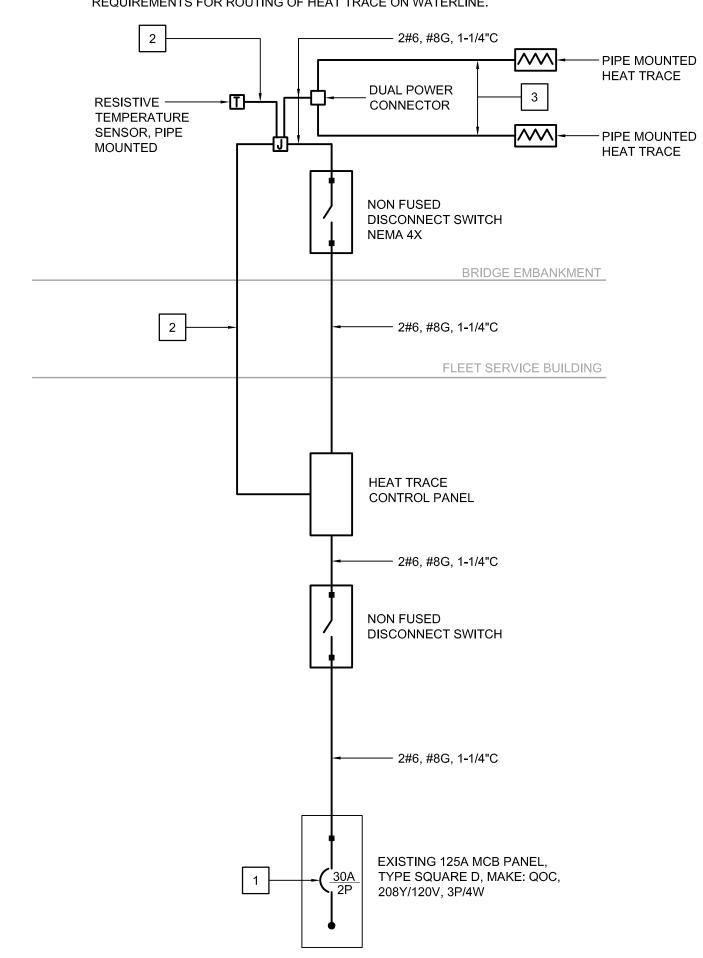

DETAIL NOTES:

- PROVIDE CIRCUIT BREAKER TYPE AND MOUNTING TO MATCH EXISTING. CIRCUIT 1 | BREAKER SIZED PER HEAT TRACE MANUFACTURER REQUIREMENTS.
- 2 PROVIDE CONTROL WIRING PER HEAT TRACE MANUFACTURER REQUIREMENTS.
- 3 PROVIDE WIRING PER HEAT TRACE MANUFACTURER REQUIREMENTS.

PARTIAL ONE LINE DIAGRAM

SCALE: NONE

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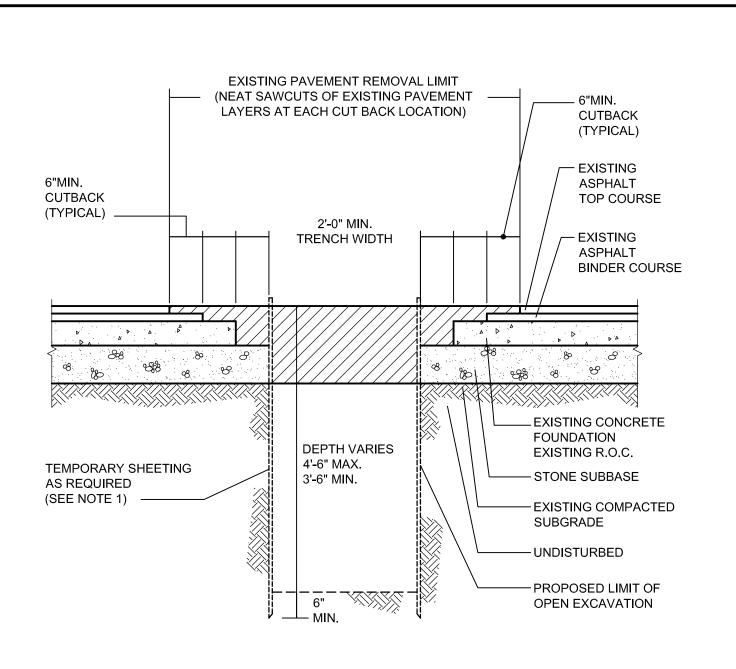
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DRAWING TITLE

ELECTRICAL -**NEW WORK**


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PAVEMENT CUT AND DUCTBANK TRENCH DETAIL E-2 NO SCALE

GENERAL NOTE:


- A. CONTRACTOR SHALL PROVIDE TEMPORARY SHEETING AND BRACING AS REQUIRED DURING OPEN EXCAVATION. TEMPORARY SHEETING AND BRACING SHALL COMPLY WITH THE REQUIREMENTS OF TITLE 29 CODE OF FEDERAL REGULATIONS PART 1926, SAFETY AND HEALTH REGULATIONS FOR CONSTRUCTION (OSHA), IN PARTICULAR TO SECTION 1926.652 REGARDING SAFETY AND PROTECTION OF PERSONS EMPLOYED IN AN OPEN EXCAVATION; OR BE DESIGNED BY A REGISTERED PROFESSIONAL ENGINEER LICENSED IN THE STATE OF NEW YORK.
- B. SOME COURSES MAY NOT BE PRESENT



CONCRETE SIDEWALK REMOVAL AND DUCTBANK TRENCH EXCAVATION DETAIL NO SCALE

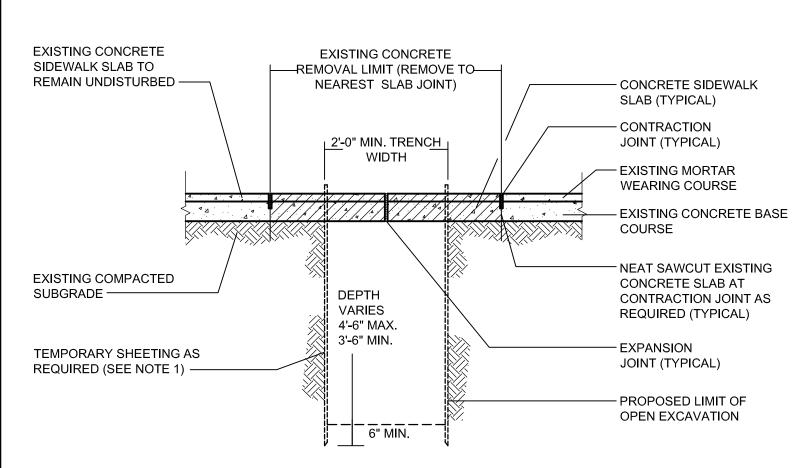GENERAL NOTES:


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- B. SOME COURSES MAY NOT BE PRESENT.

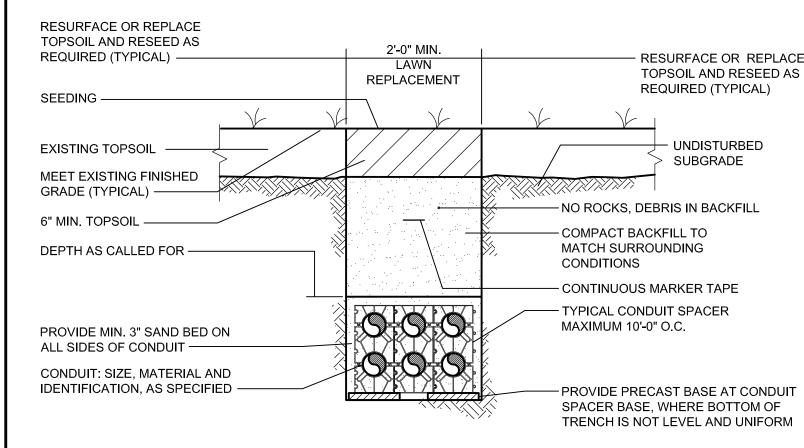

3 LAWN REPLACEMENT DETAIL E-2 NO SCALE

GENERAL NOTES:


- A. GRASS SEED SHALL CONTAIN 50% KENTUCKY BLUE GRASS, 30% RED TOP, AND 20% PERENNIAL RYE GRASS.
- B. REPAIR ALL SETTLEMENT WITH TOPSOIL, RESEED. MAINTAIN AS CALLED FOR.
- C. REFER TO DUCTBANK SECTION AND/OR ONE-LINE DIAGRAM FOR ACTUAL QUANTITY AND SIZE OF CONDUITS REQUIRED.
- D. LEAVE PULL ROPE IN ALL SPARES.
- E. EXCAVATED MATERIAL MEETING SPECIFICATIONS MAY BE USED FOR BACKFILL IN TRENCHES. IN THE EVENT EXCAVATED MATERIAL DOES NOT MEET SPECIFICATIONS, PROVIDE GRANULAR BACKFILL AS SPECIFIED FOR BACKFILL. REMOVE UNSUITABLE MATERIAL FROM SITE.
- F. UNLESS OTHERWISE NOTED, TOP OF CONDUIT SHALL BE 30" BELOW FINISHED GRADE.
- G. SPACERS AND PRECAST BASE MAY BE DELETED FOR SINGLE TIER DUCTBANK SECTIONS.

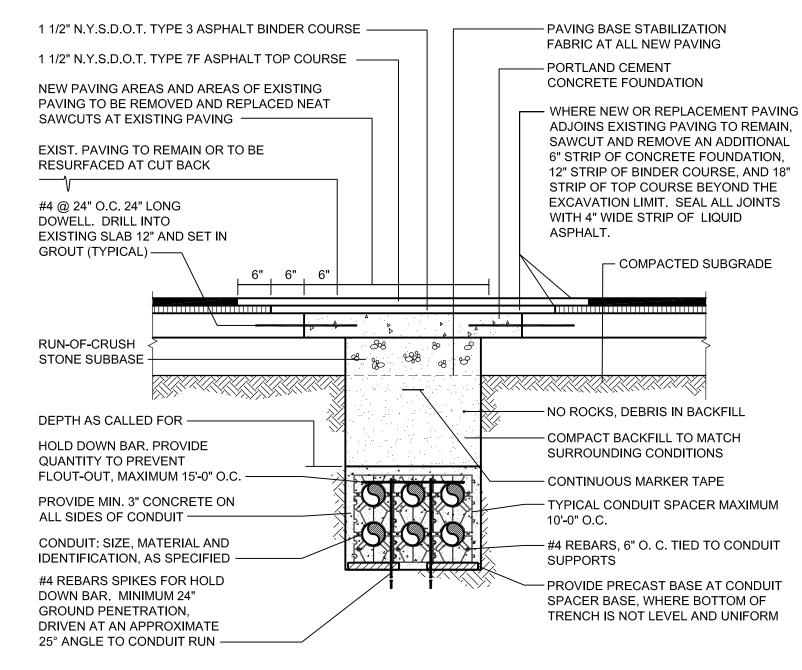

PAVEMENT RESTORATION DETAIL NO SCALE

GENERAL NOTE:

- A. SOME COURSES MAY NOT BE PRESENT.
- F. REFER TO DUCTBANK SECTION AND/OR ONE-LINE DIAGRAM FOR ACTUAL QUANTITY AND SIZE OF CONDUITS
- G. LEAVE PULL ROPE IN ALL SPARES.
- H. EXCAVATED MATERIAL MEETING SPECIFICATIONS MAY BE USED FOR BACKFILL IN TRENCHES. IN THE EVENT EXCAVATED MATERIAL DOES NOT MEET SPECIFICATIONS, PROVIDE GRANULAR BACKFILL AS SPECIFIED FOR BACKFILL. REMOVE UNSUITABLE MATERIAL FROM SITE.
- I. UNLESS OTHERWISE NOTED, TOP OF CONDUIT SHALL BE 30" BELOW FINISHED GRADE.

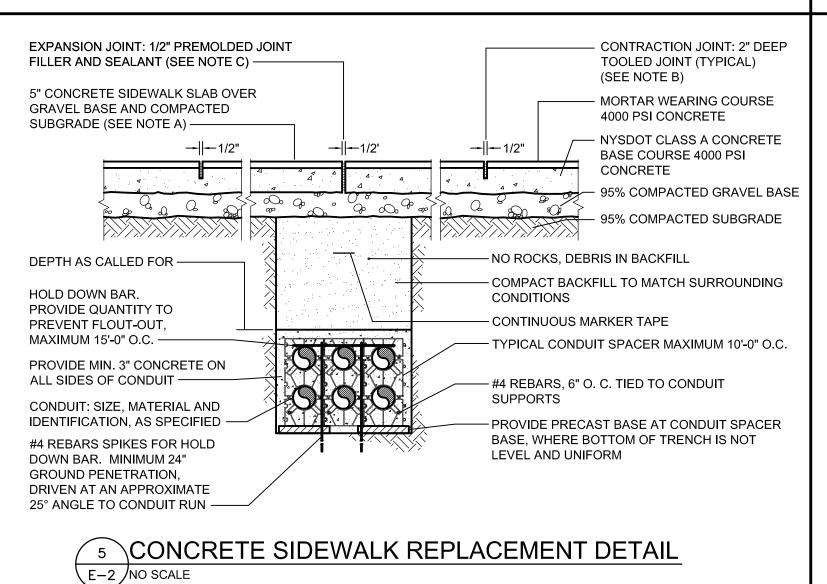

GENERAL NOTES:


- A. CONCRETE SIDEWALK SHALL BE CONSTRUCTED OF RECTANGULAR SLAB, WHICH SHALL NOT HAVE ANY DIMENSION GREATER THAN 6'-0". BETWEEN CONTRACTION OR EXPANSION JOINTS AND SHALL BE REINFORCED WITH 6"x6" (W1.4xW1.4) WELDED WIRE MESH. WELDED WIRE MESH, SHALL BE PLACED 2" FROM THE TOP OF THE CONCRETE BASE COURSE.
- B. CONTRACTION (TOOLED) JOINTS SHALL BE PLACED BETWEEN EXPANSION JOINTS AT EQUAL INTERVALS NOT TO EXCEED 6'-0". THESE JOINTS SHALL BE FORMED EITHER BY THE USE OF STEEL PLATES OR BY APPROVED METHOD OF CUTTING A GROOVE IN THE SURFACE OF THE FINISHED CONCRETE.
- C. EXPANSION JOINT MATERIAL SHALL BE PREMOLDED STRIPS OF ASPHALT FELT OF 0.239" THICKNESS, AS DEEP AS
- D. PROVIDE EXPANSION JOINTS WHERE CONCRETE SIDEWALK LINE INTERSECTS BUILDING WALLS, PERMANENT

THE THICKNESS OF THE WALK, AND LAID IN ONE PIECE AS LONG AS THE FULL WIDTH OF SLAB.

- E. PROVIDE STIFF BROOM FINISH PERPENDICULAR TO DIRECTION OF TRAFFIC PATTERN. MAINTAIN 2" SMOOTH BORDER AT ALL JOINTS.
- REFER TO DUCTBANK SECTION AND/OR ONE-LINE DIAGRAM FOR ACTUAL QUANTITY AND SIZE OF CONDUITS
- G. LEAVE PULL ROPE IN ALL SPARES.

STRUCTURES, OR OTHER ADJACENT SIDEWALK SLABS.

- H. EXCAVATED MATERIAL MEETING SPECIFICATIONS MAY BE USED FOR BACKFILL IN TRENCHES. IN THE EVENT EXCAVATED MATERIAL DOES NOT MEET SPECIFICATIONS, PROVIDE GRANULAR BACKFILL AS SPECIFIED FOR BACKFILL. REMOVE UNSUITABLE MATERIAL FROM SITE.
- I. UNLESS OTHERWISE NOTED, TOP OF CONDUIT SHALL BE 30" BELOW FINISHED GRADE.

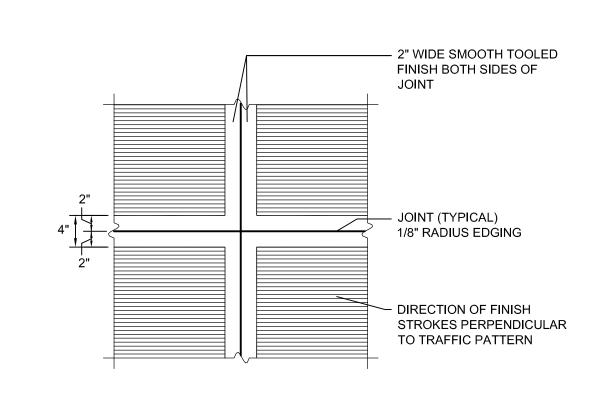





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